



- A. EXTERIOR DIMENSIONS ARE TO THE OUTSIDE FACE OF CONCRETE
- B. INTERIOR DIMENSIONS ARE TO THE FACE OF STUDS AT FRAMED WALLS, AND TO CENTERLINE OF COLUMNS UNLESS OTHERWISE NOTED.
- DIMENSIONS LOCATING DOORS, WINDOWS AND RELIGHTS ARE TO FINISH

- E. ALL NON-BEARING WALLS ARE FULL HEIGHT TO UNDERSIDE OF ROOF DECK
- F. APPLY TWO (2) CONTINUOUS SEALANT BEADS BENEATH STUD TRACK AT ALL
- G. CONTRACTOR SHALL PROVIDE CONTINUOUS HORIZONTAL BLOCKING AS REQUIRED AT ALL WALL MOUNTED LAVATORIES, DRINKING FOUNTAINS, CASEWORK, MIRRORS, HANDRAILS, ETC. REFER TO ARCHITECTURAL

KEYNOTE

03 3100.C1

05 0523.E 10 5614

11 1136

26 0125

34 7114

34 7120

11 8213.B6

32 1723.14 33 4416

- H. SEE DRAWING A6.01 FOR TYPICAL MOUNTING HEIGHTS FOR WALL MOUNTED ACCESSORIES, BLOCKING, AND EQUIPMENT.
- SEE REFLECTED CEILING PLAN FOR CEILING MOUNTED EQUIPMENT. CONFIRM ACCESSIBILITY CLEARANCE REQUIREMENTS AS NOTED ON SHEETS
- A6.01 AND A6.02.
- REFER TO SHEET A7.10 FOR TYPICAL DOOR CLEARANCES. ANGLES ARE 30 DEGREES, 45 DEGREES, OR 90 DEGREES U.N.O.
- M. SEAL AROUND ALL PENETRATIONS AT FIRE RATED WALLS, INCLUDING BUT NOT LIMITED TO PIPING, DUCTS, CONDUIT, ETC., WITH FIRESTOPPING PER I.B.C. REQUIREMENTS.
- N. SEE EXTERIOR ELEVATIONS FOR WINDOW AND LOUVER TYPES AND DETAILS. O. SEE ENLARGED PLANS FOR ADDITIONAL DIMENSIONAL AND NOTE
- INFORMATION. P. RAILING COMPONENTS ARE SHOWN DIAGRAMMATICALLY IN PLANS AND ELEVATIONS AND SHOULD NOT BE USED AS DIRECTION FOR FABRICATION U.N.O. REFER TO RAILING DETAILS FOR ACCURATE LOCATIONS AND DIMENSIONS OF RAILING COMPONENTS.

KEYNOTE TEXT

EV CHARGING STATION FOR 2 VEHICLES (INFRASTRUCTURE ONLY)

KEYNOTE LEGEND

C.I.P. CONCRETE COLUMN

WALL MOUNTED BIKE RACKS

PAINTED DIRECTIONAL ARROW

PREFABRICATED TRENCH FORMING DRAIN

VAN ACCESSIBLE SPACE PAINTED MARK

WIRE MESH PANEL

6-YD DUMPSTER ELECTRICAL PANELS

CONC. WHEEL STOP



CONSULTANT:

REGISTRATION STAMPS:



PROJECT IDENTIFICATION:

Williams Invest -Third and Park FOR 5J WILLIAMS FAMILY LLC

AT 3RD & PARK AVE

BUILDING PERMIT 01/30/2023

MUKILTEO, WA 98275

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2021-042

REVISIONS:

MARK DATE DESCRIPTION 01/30/2023 BUILDING PERMIT

PROJECT TEAM:

PRINCIPAL IN CHARGE: MAS PROJECT MANAGER: | AM PROJECT ARCHITECT: | WDH JOB CAPTAIN:


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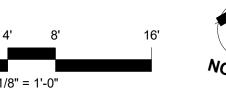
FLOOR PLAN - PARKING LEVEL


DRAWING NUMBER:

A1.10

CITY OF MUKILTEO **Received by Email** 1/30/2023



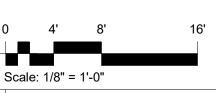

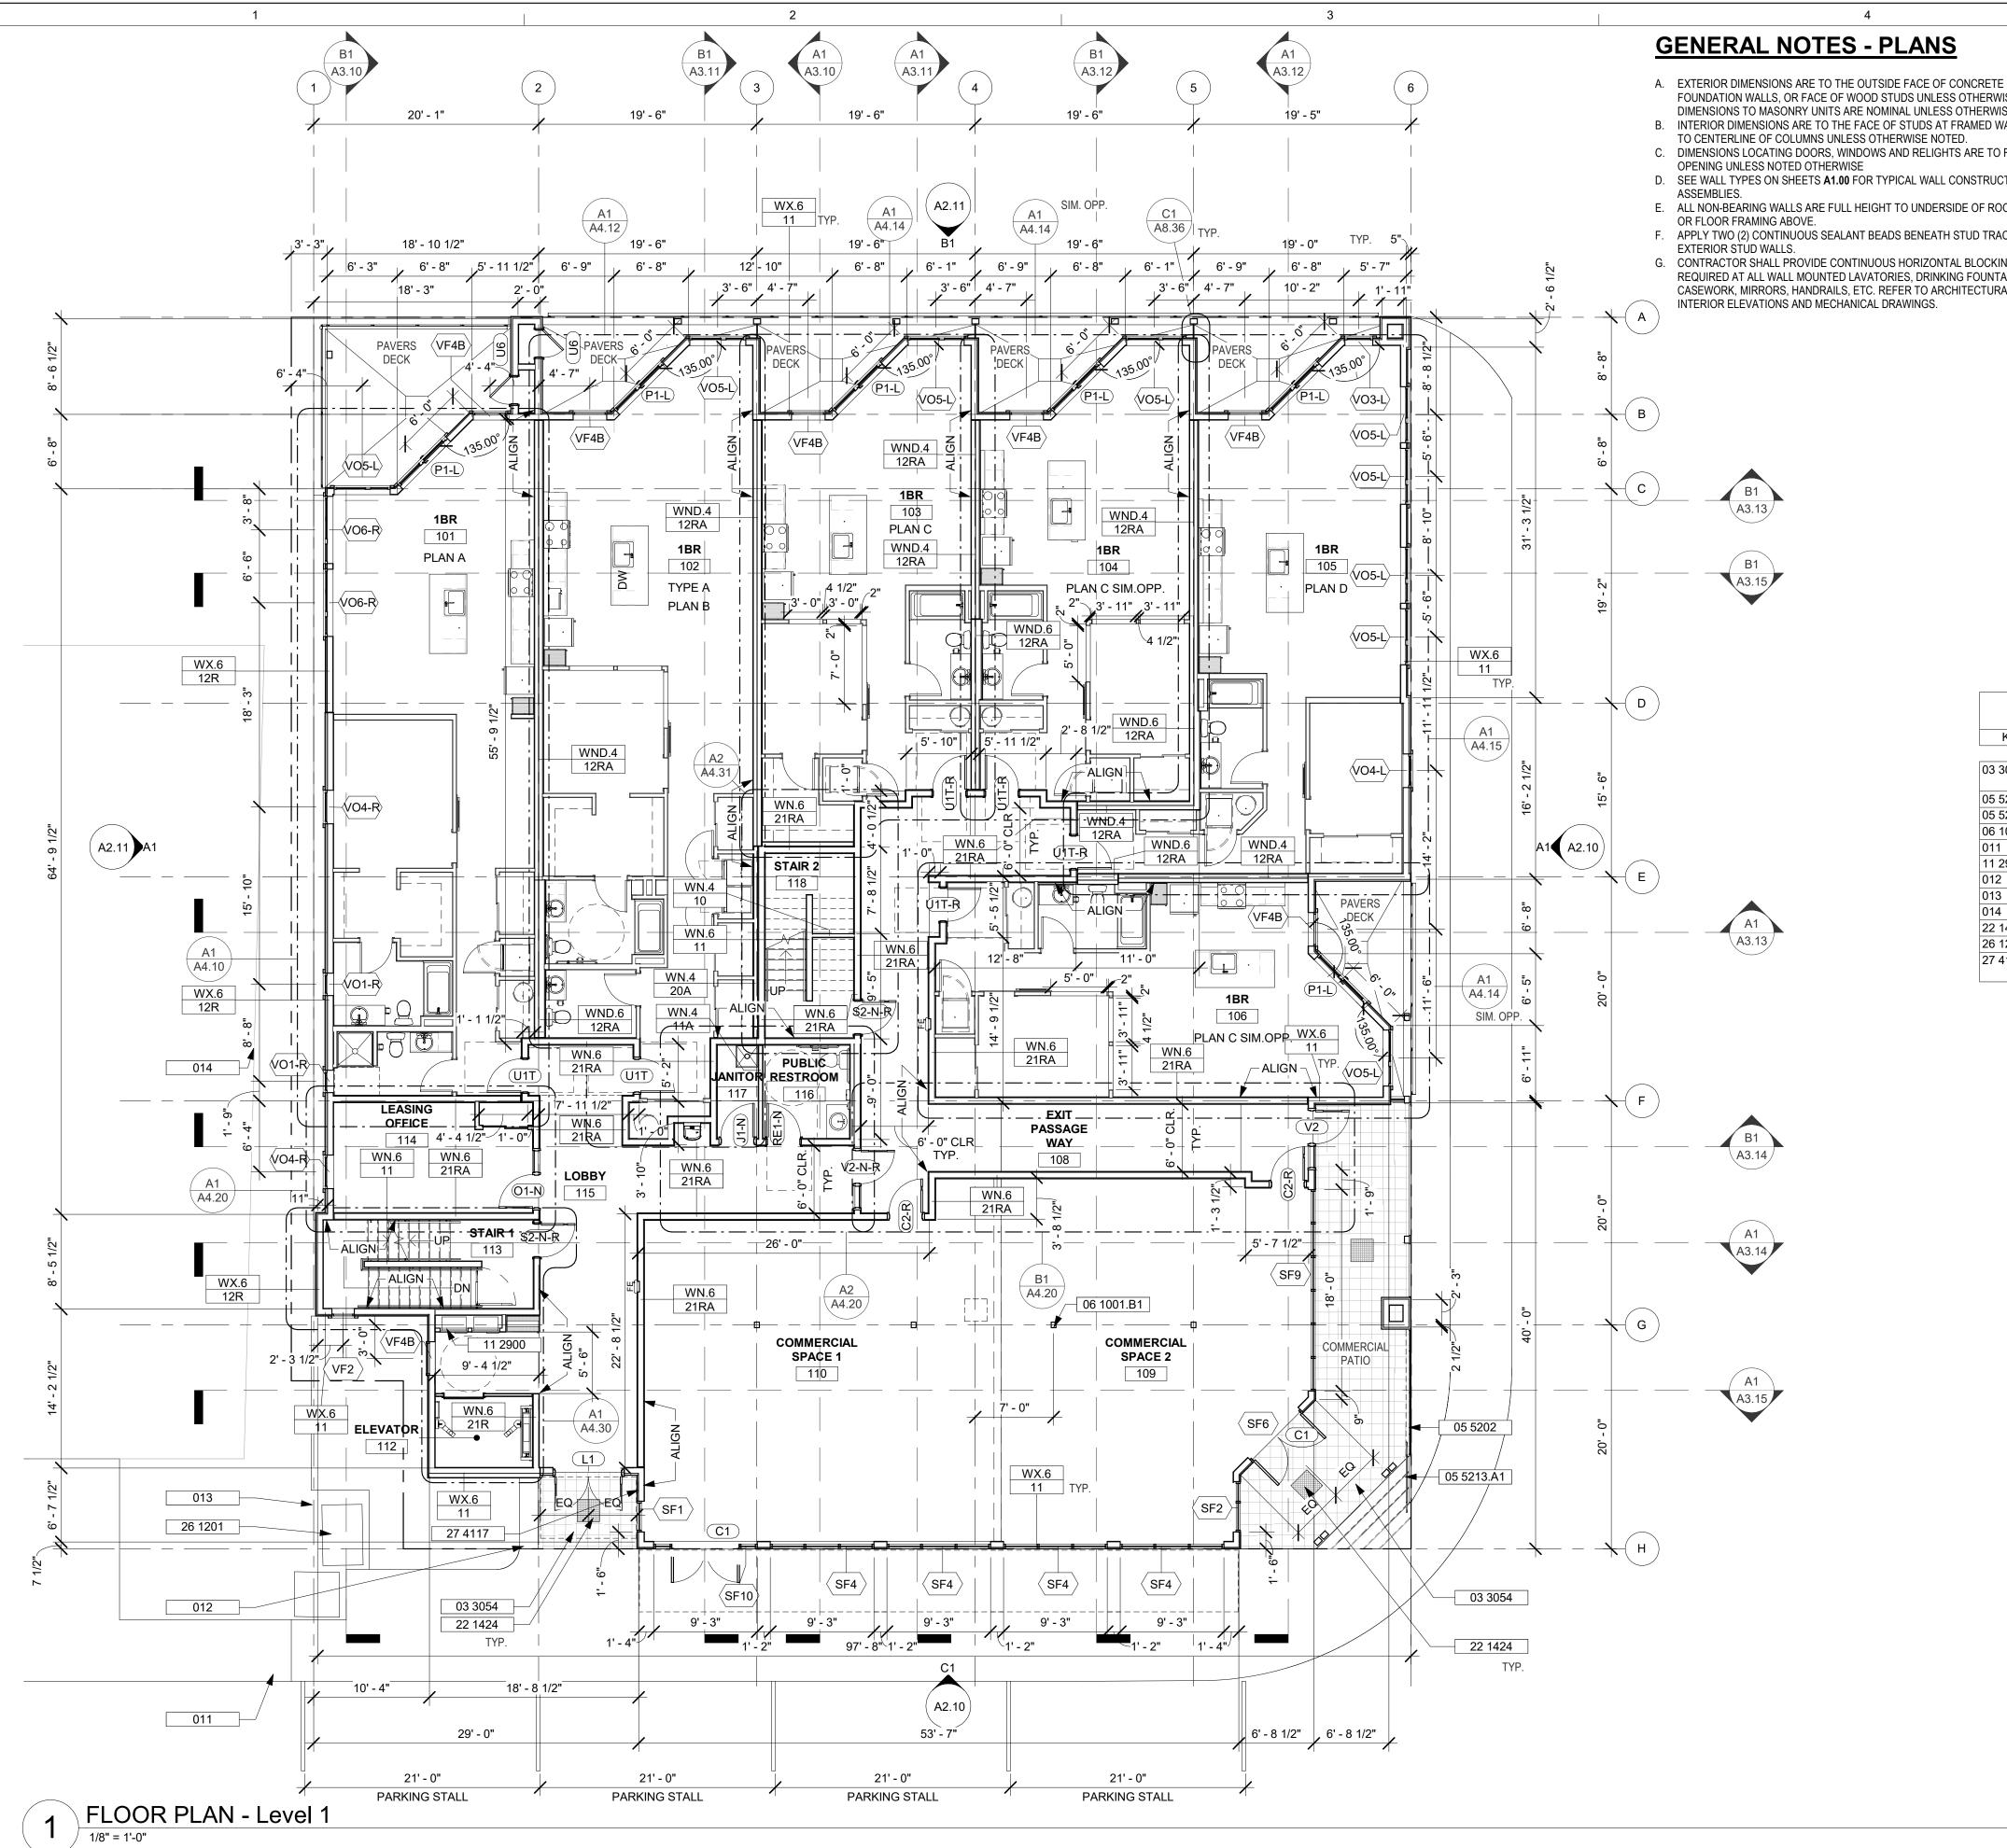

3

- FOUNDATION WALLS, OR FACE OF WOOD STUDS UNLESS OTHERWISE NOTED.
- . INTERIOR DIMENSIONS ARE TO THE FACE OF STUDS AT FRAMED WALLS, AND TO CENTERLINE OF COLUMNS UNLESS OTHERWISE NOTED.
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KEYNOTE LEGEND

DECORATIVE STAMPED CONCRETE, TYP. AT PRIMARY ENTRIES

CABLE RAIL GUARDRAIL PER MFR

WOOD COLUMN PER STRUCTURAL

ARCHITECTURAL SEAT WALL

LINE OF ADJACENT BUILDING

COORDINATE W/ ELECTRICAL

PUD TRANSFORMER AND VAULT

Scale: 1/8" = 1'-0"

EXISTING SIDEWALK

PROPERTY LINE

DRAINAGE GRILLE

1 1/2" DIAM. HOT DIP GALVANIZED HANDRAIL

POSTAL, PACKAGING, AND SHIPPING EQUIPMENT

FUTURE INTERCOM/CALL SYSTEM DIRECTORY LOCATION.

KEYNOTE TEXT

KEYNOTE

03 3054

05 5213.A1

06 1001.B1

11 2900

013

014

22 1424

26 1201

27 4117



CONSULTANT:

REGISTRATION STAMPS:



PROJECT IDENTIFICATION:

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 AT 3RD & PARK AVE MUKILTEO, WA 98275

BUILDING PERMIT 01/30/2023

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2021-042

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	01/30/2023	BUILDING PERMIT			

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PRINCIPAL IN CHARGE: MAS PROJECT MANAGER: | AM PROJECT ARCHITECT: | WDH

DRAWING TITLE:

JOB CAPTAIN:


FLOOR PLAN - LEVEL 1

DRAWING NUMBER:

A1.11





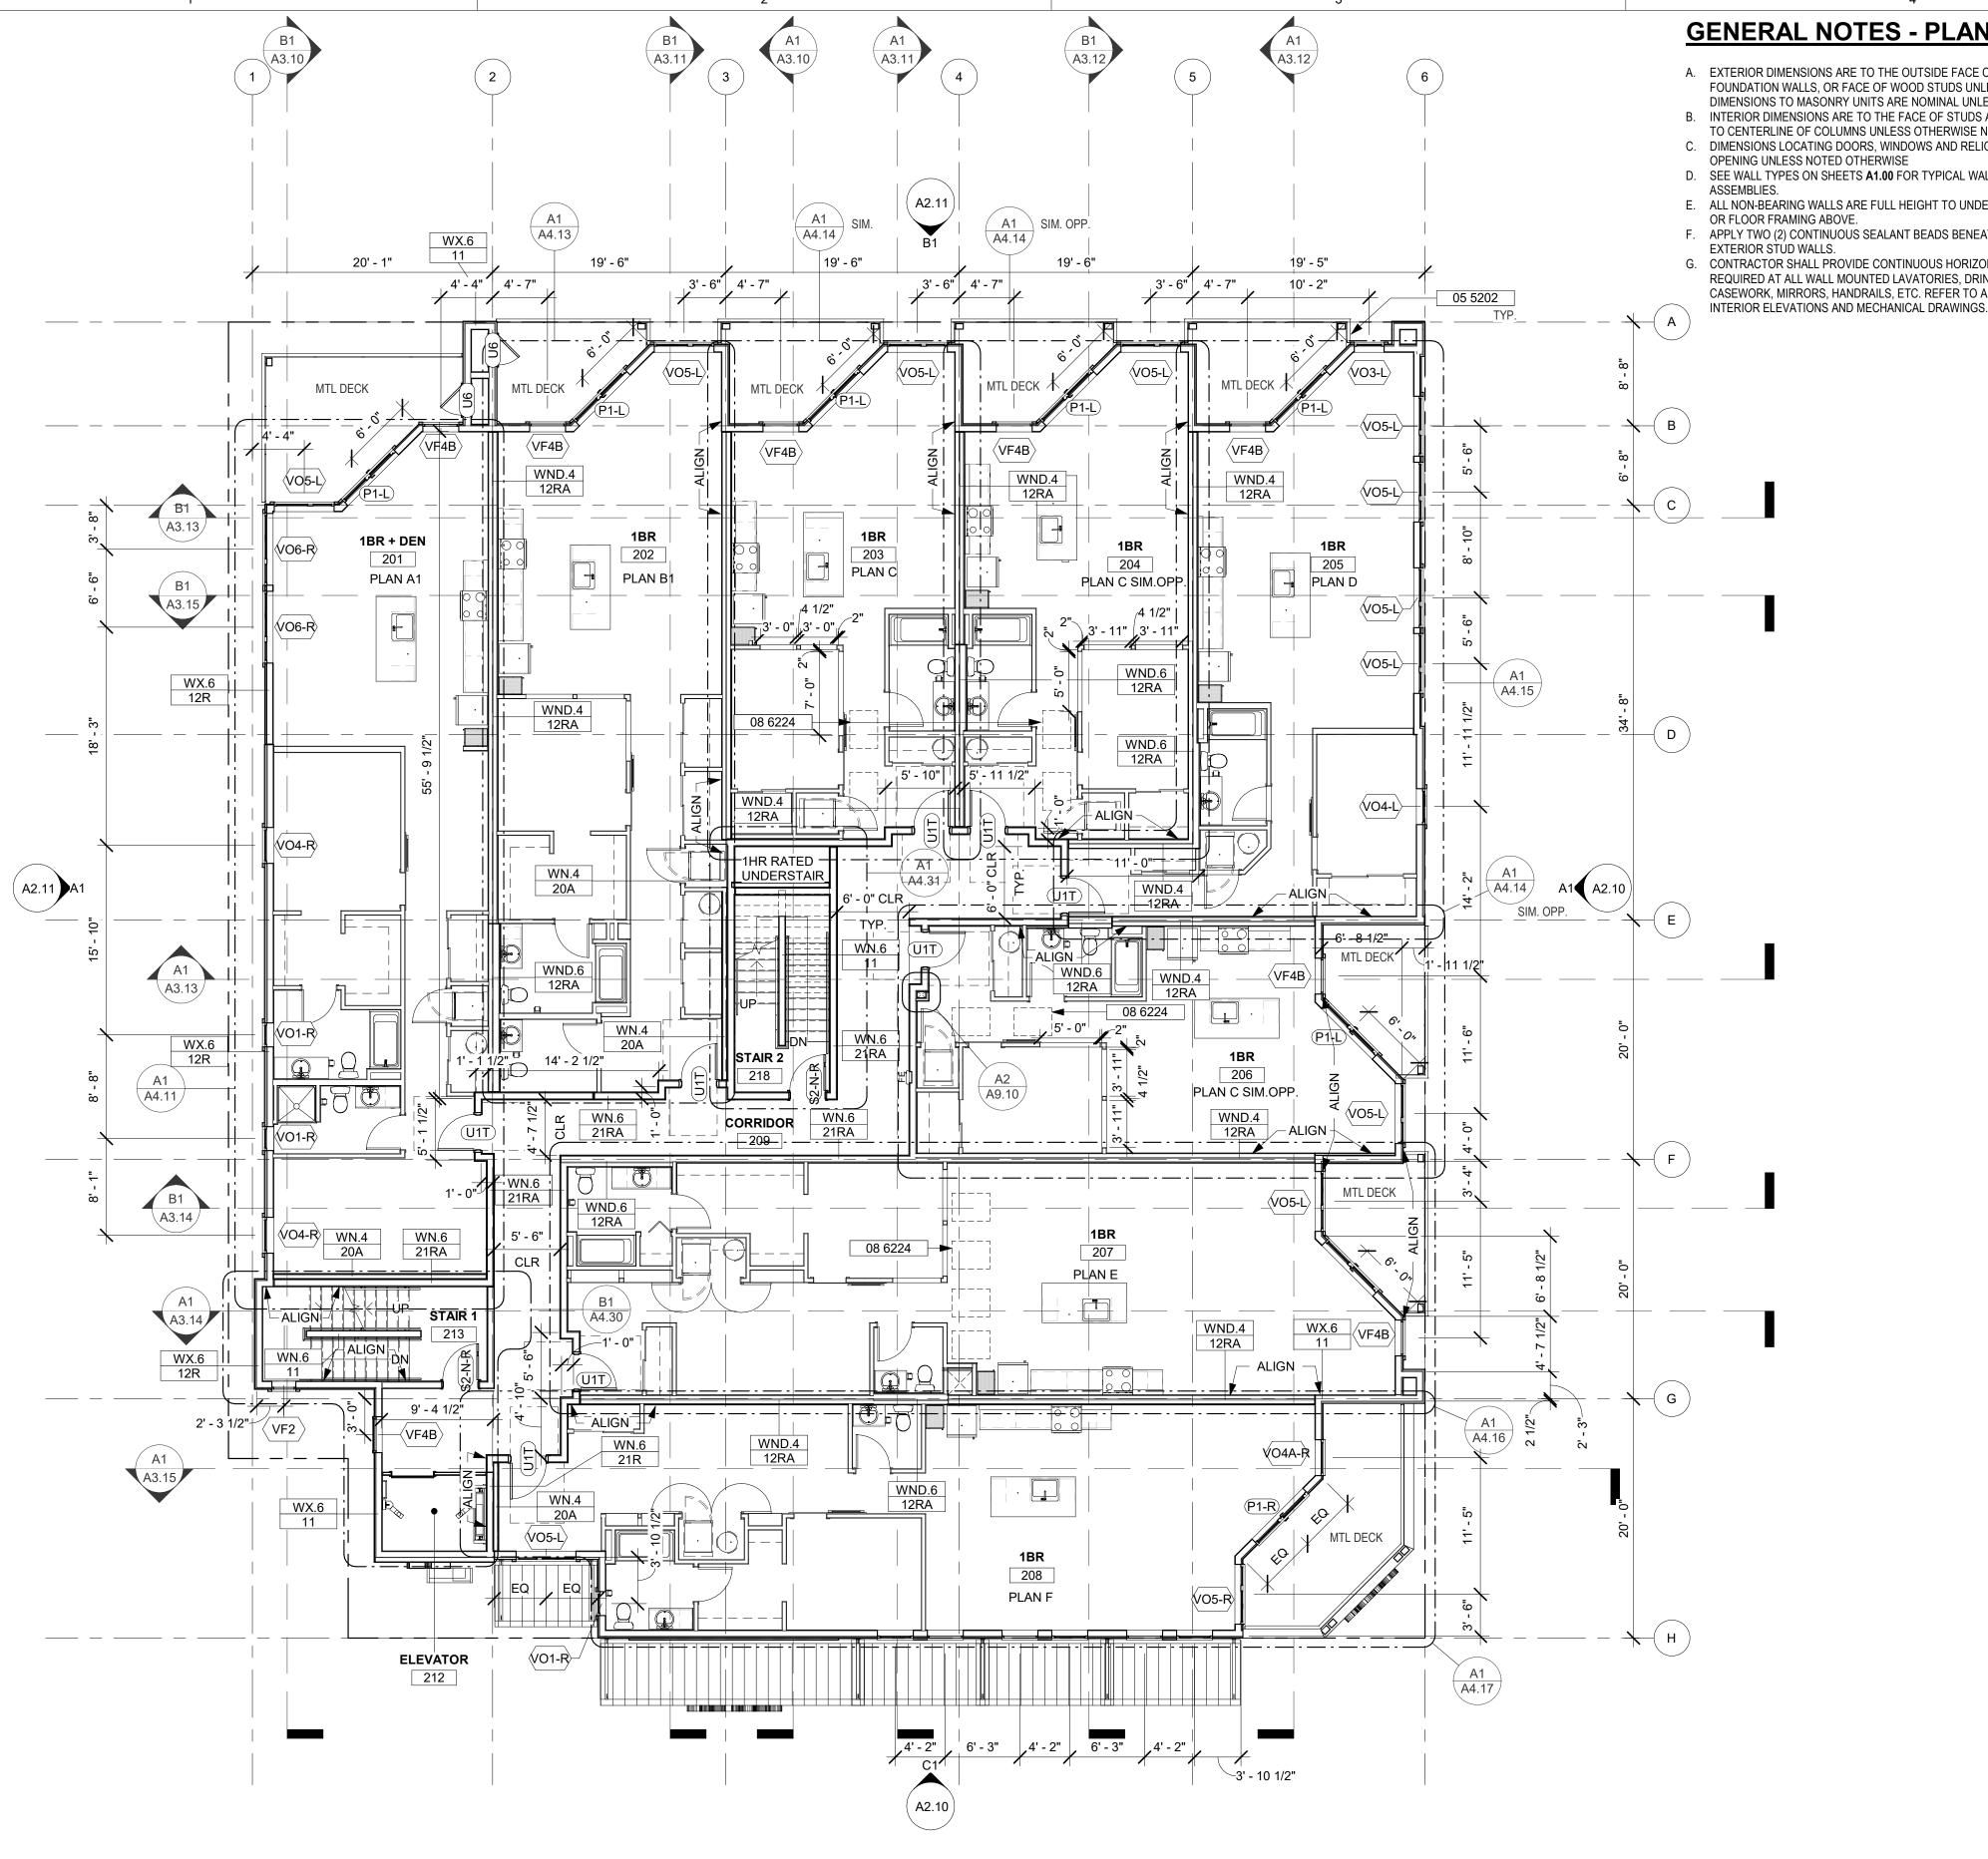

FLOOR PLAN - Level 2



- A. EXTERIOR DIMENSIONS ARE TO THE OUTSIDE FACE OF CONCRETE FOUNDATION WALLS, OR FACE OF WOOD STUDS UNLESS OTHERWISE NOTED.
- B. INTERIOR DIMENSIONS ARE TO THE FACE OF STUDS AT FRAMED WALLS, AND TO CENTERLINE OF COLUMNS UNLESS OTHERWISE NOTED.
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KEYNOTE LEGEND

CABLE RAIL GUARDRAIL PER MFR

KEYNOTE

KEYNOTE TEXT



CONSULTANT:

REGISTRATION STAMPS:



PROJECT IDENTIFICATION:

Williams Invest -Third and Park FOR 5J WILLIAMS FAMILY LLC

AT 3RD & PARK AVE MUKILTEO, WA 98275

BUILDING PERMIT 01/30/2023

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	01/30/2023	BUILDING PERMIT				

PROJECT TEAM:


PRINCIPAL IN CHARGE: MAS PROJECT MANAGER: | AM PROJECT ARCHITECT: | WDH JOB CAPTAIN:

DRAWING TITLE:


FLOOR PLAN - LEVEL 2

DRAWING NUMBER:


A1.12

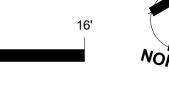

Scale: 1/8" = 1'-0"

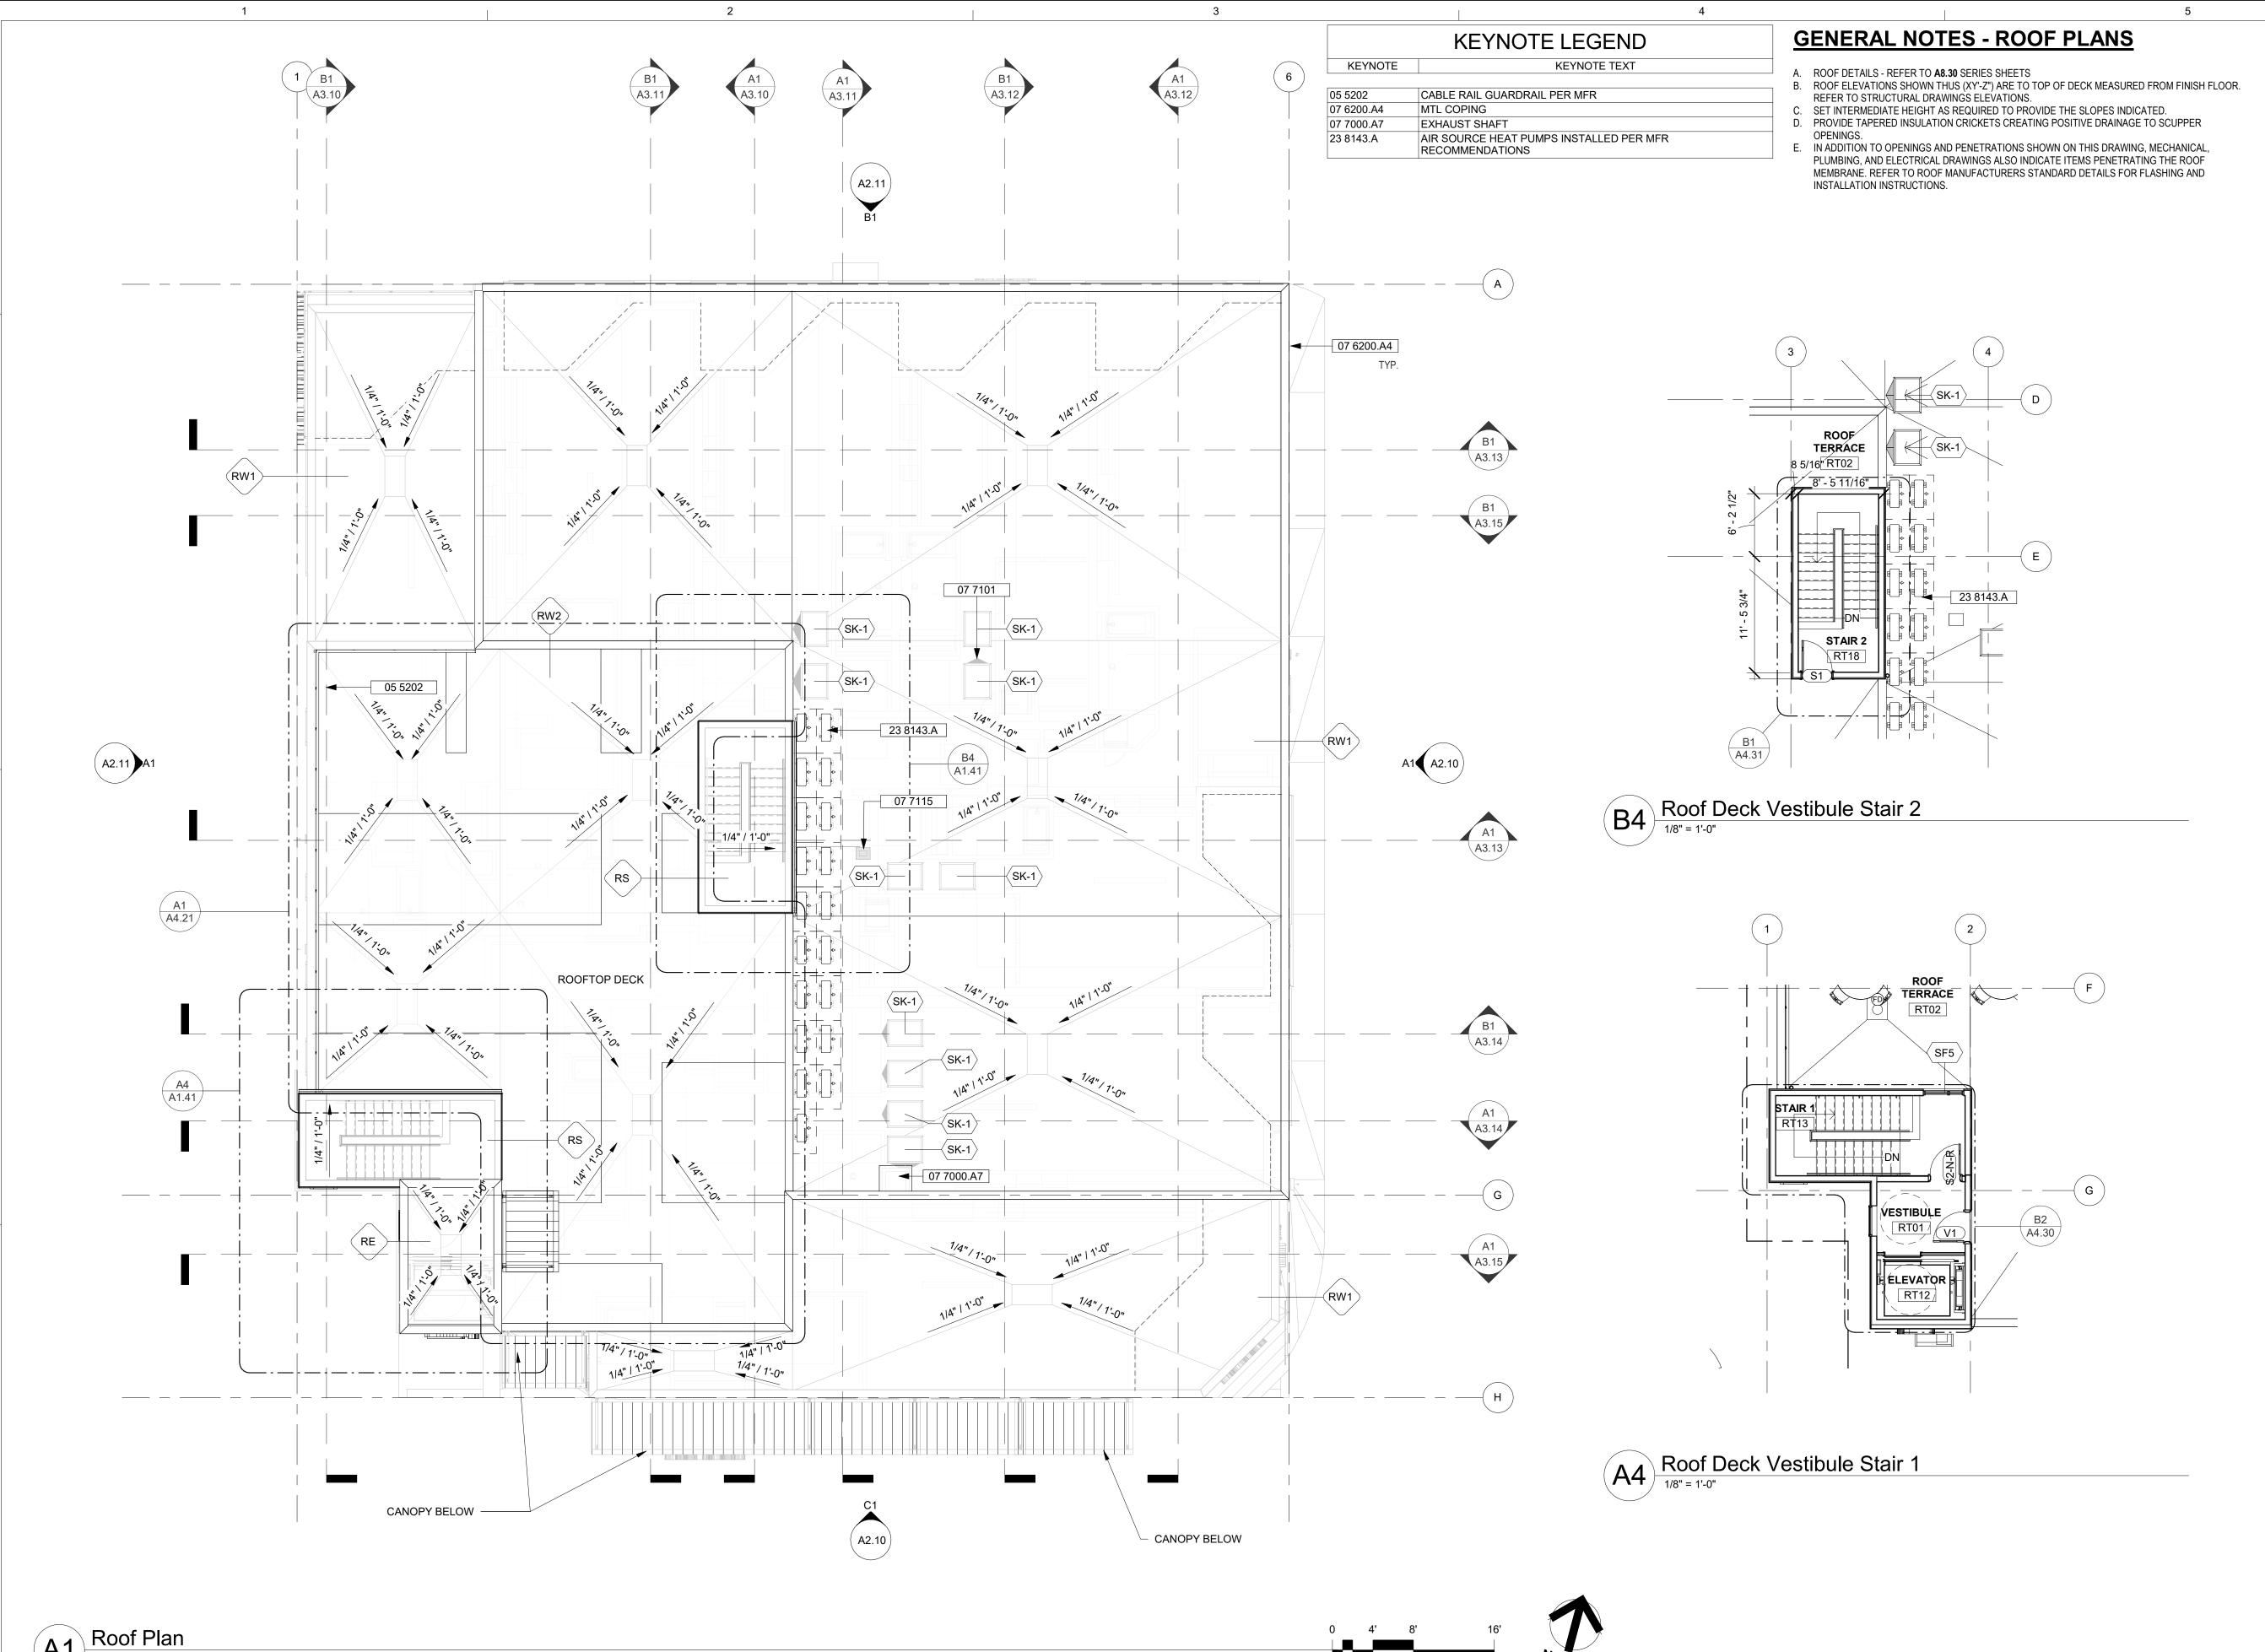

Scale: 1/8" = 1'-0"

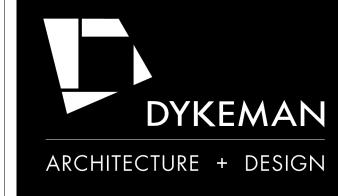

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REGISTRATION STAMPS:



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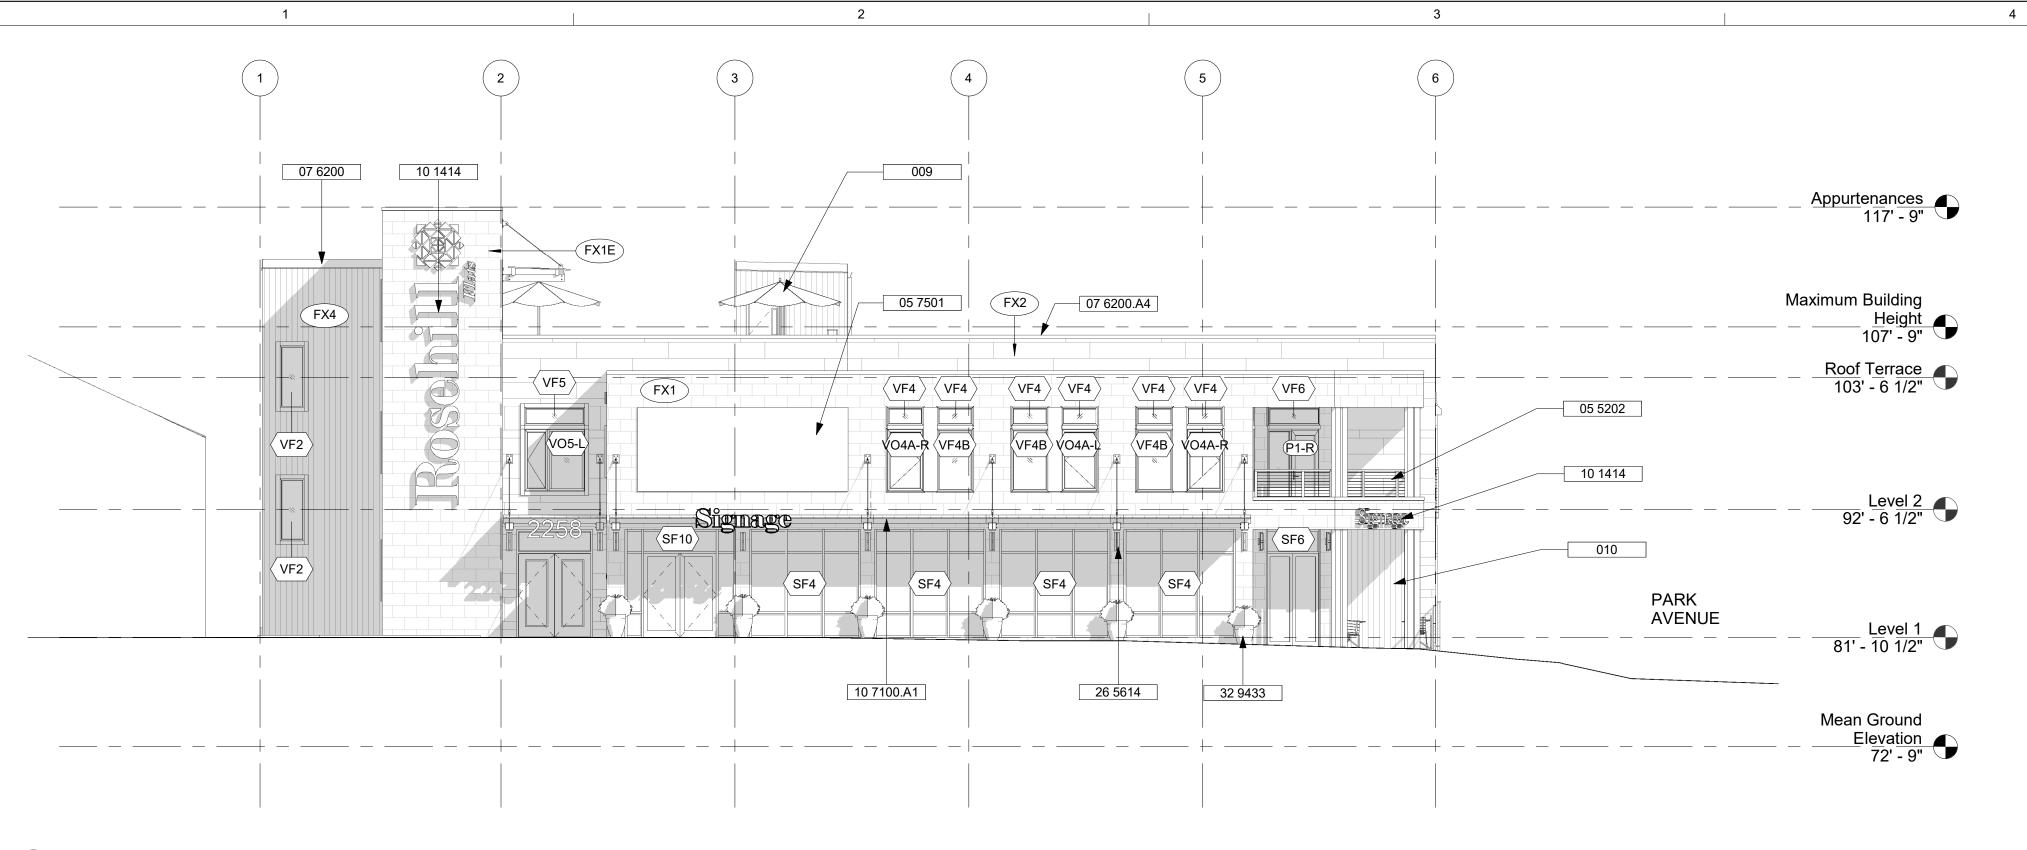
PRINCIPAL IN CHARGE: MAS PROJECT MANAGER: | AM PROJECT ARCHITECT: | WDH JOB CAPTAIN:

DRAWING TITLE:


ROOF PLAN

DRAWING NUMBER:

A1.41



Elevation - South (3rd Street)

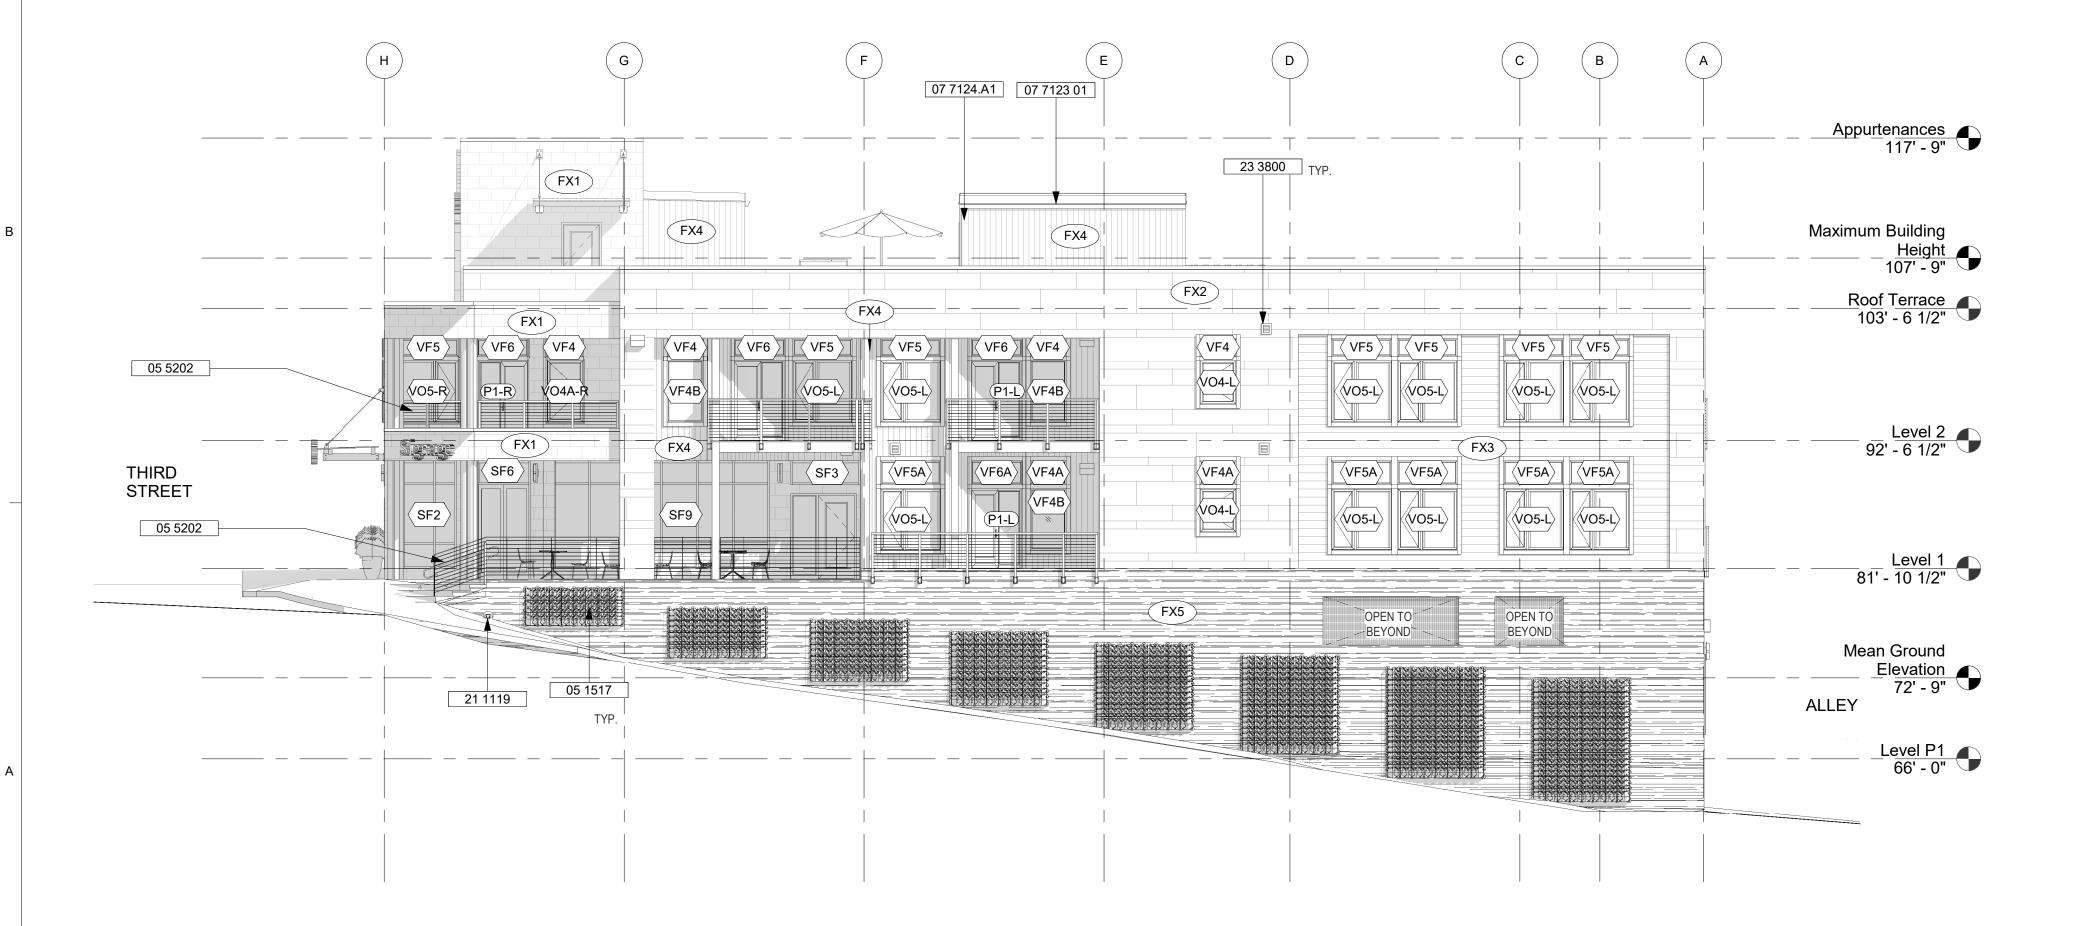

3

GENERAL NOTES - EXTERIOR ELEVATIONS

- A. EXTERIOR MATERIAL TYPES REFER TO **MATERIAL LEGEND** THIS SHEET. B. DOWNSPOUTS SUPPORTS - FOR DOWNSPOUTS UP TO 12'-0" IN LENGTH PROVIDE 2 PREFINISHED METAL STRAPS (TOP AND BOTTOM). 12'-0" AND LONGER PROVIDE 3 PREFINISHED METAL STRAPS
- (TOP, MIDDLE AND BOTTOM).
- C. WALL TYPES SEE SHEET A1.00 D. WINDOW TYPES & GLAZING IDENTIFICATION - REFER TO WINDOW SCHEDULE ON SHEET A7.20
- E. EXTERIOR DETAILS SEE **A8.00** SERIES SHEETS

32 9433

PLANTERS

F. KNOX BOX - PROVIDE A KNOX BOX AS SPECIFIED. COORDINATE LOCATION WITH THE OWNER AND THE FIRE MARSHAL



CONSULTANT:

KEYNOTE LEGEND KEYNOTE TEXT KEYNOTE 05 1517 CABLE TRELLIS ASSEMBLY 05 5202 CABLE RAIL GUARDRAIL PER MFR 05 7501 DECORATIVE SHEET METAL. COLOR TO MATCH WINDOWS TRIM 07 6200 SHEET METAL FLASHING AND TRIM 07 6200.A4 MTL COPING 07 7123 01 PREFINISHED GUTTER 07 7124.A1 DOWNSPOUT, TYP. ROOF TERRACE AMENITY FURNITURE, TBD. PROPOSED ART LOCATION MMC 17.25A.040.B.6.B.VIII EXTERIOR SIGNAGE. TBD 10 1414 WOOD TIMBER CANOPY WITH CORRUGATED METAL ON TOP. TIE 10 7100.A1 ROD BACK TO 4X6 WOOD POST IN WALL. FIRE DEPARTMENT CONNECTION. VFY LOCATION W/ FIRE DEPT. 21 1119 23 3800 VENTILATION HOODS 26 5614 WALL SCONCES

REGISTRATION STAMPS:



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PROJECT NUMBER:

REVISIONS:

MARK

2021-042

01/30/2023 BUILDING PERMIT

DESCRIPTION

MATERIAL LEGEND - EXTERIOR ELEVATIONS					
	FX1 STONE VENEER				
	FX2 FIBER CEMENT PANEL				
	FX3 FIBER CEMENT LAP SIDING 7" EXPOSURE				
	FX4 WOOD-LOOK VERTICAL SHIP-LAP SIDING				
	FX5 CONCRETE - CAST-IN-PLACE BOARD-FORM FINISH				

PROJECT TEAM: PRINCIPAL IN CHARGE: MAS PROJECT MANAGER: | AM PROJECT ARCHITECT: | WDH JOB CAPTAIN: **DRAWING TITLE:**


EXTERIOR ELEVATIONS

DRAWING NUMBER:

A2.10

Elevation - East (Park Avenue) 1/8" = 1'-0"

SEE - FINISH MATERIAL KEY ON SHEET **AX.XX** FOR PAINT COLORS.

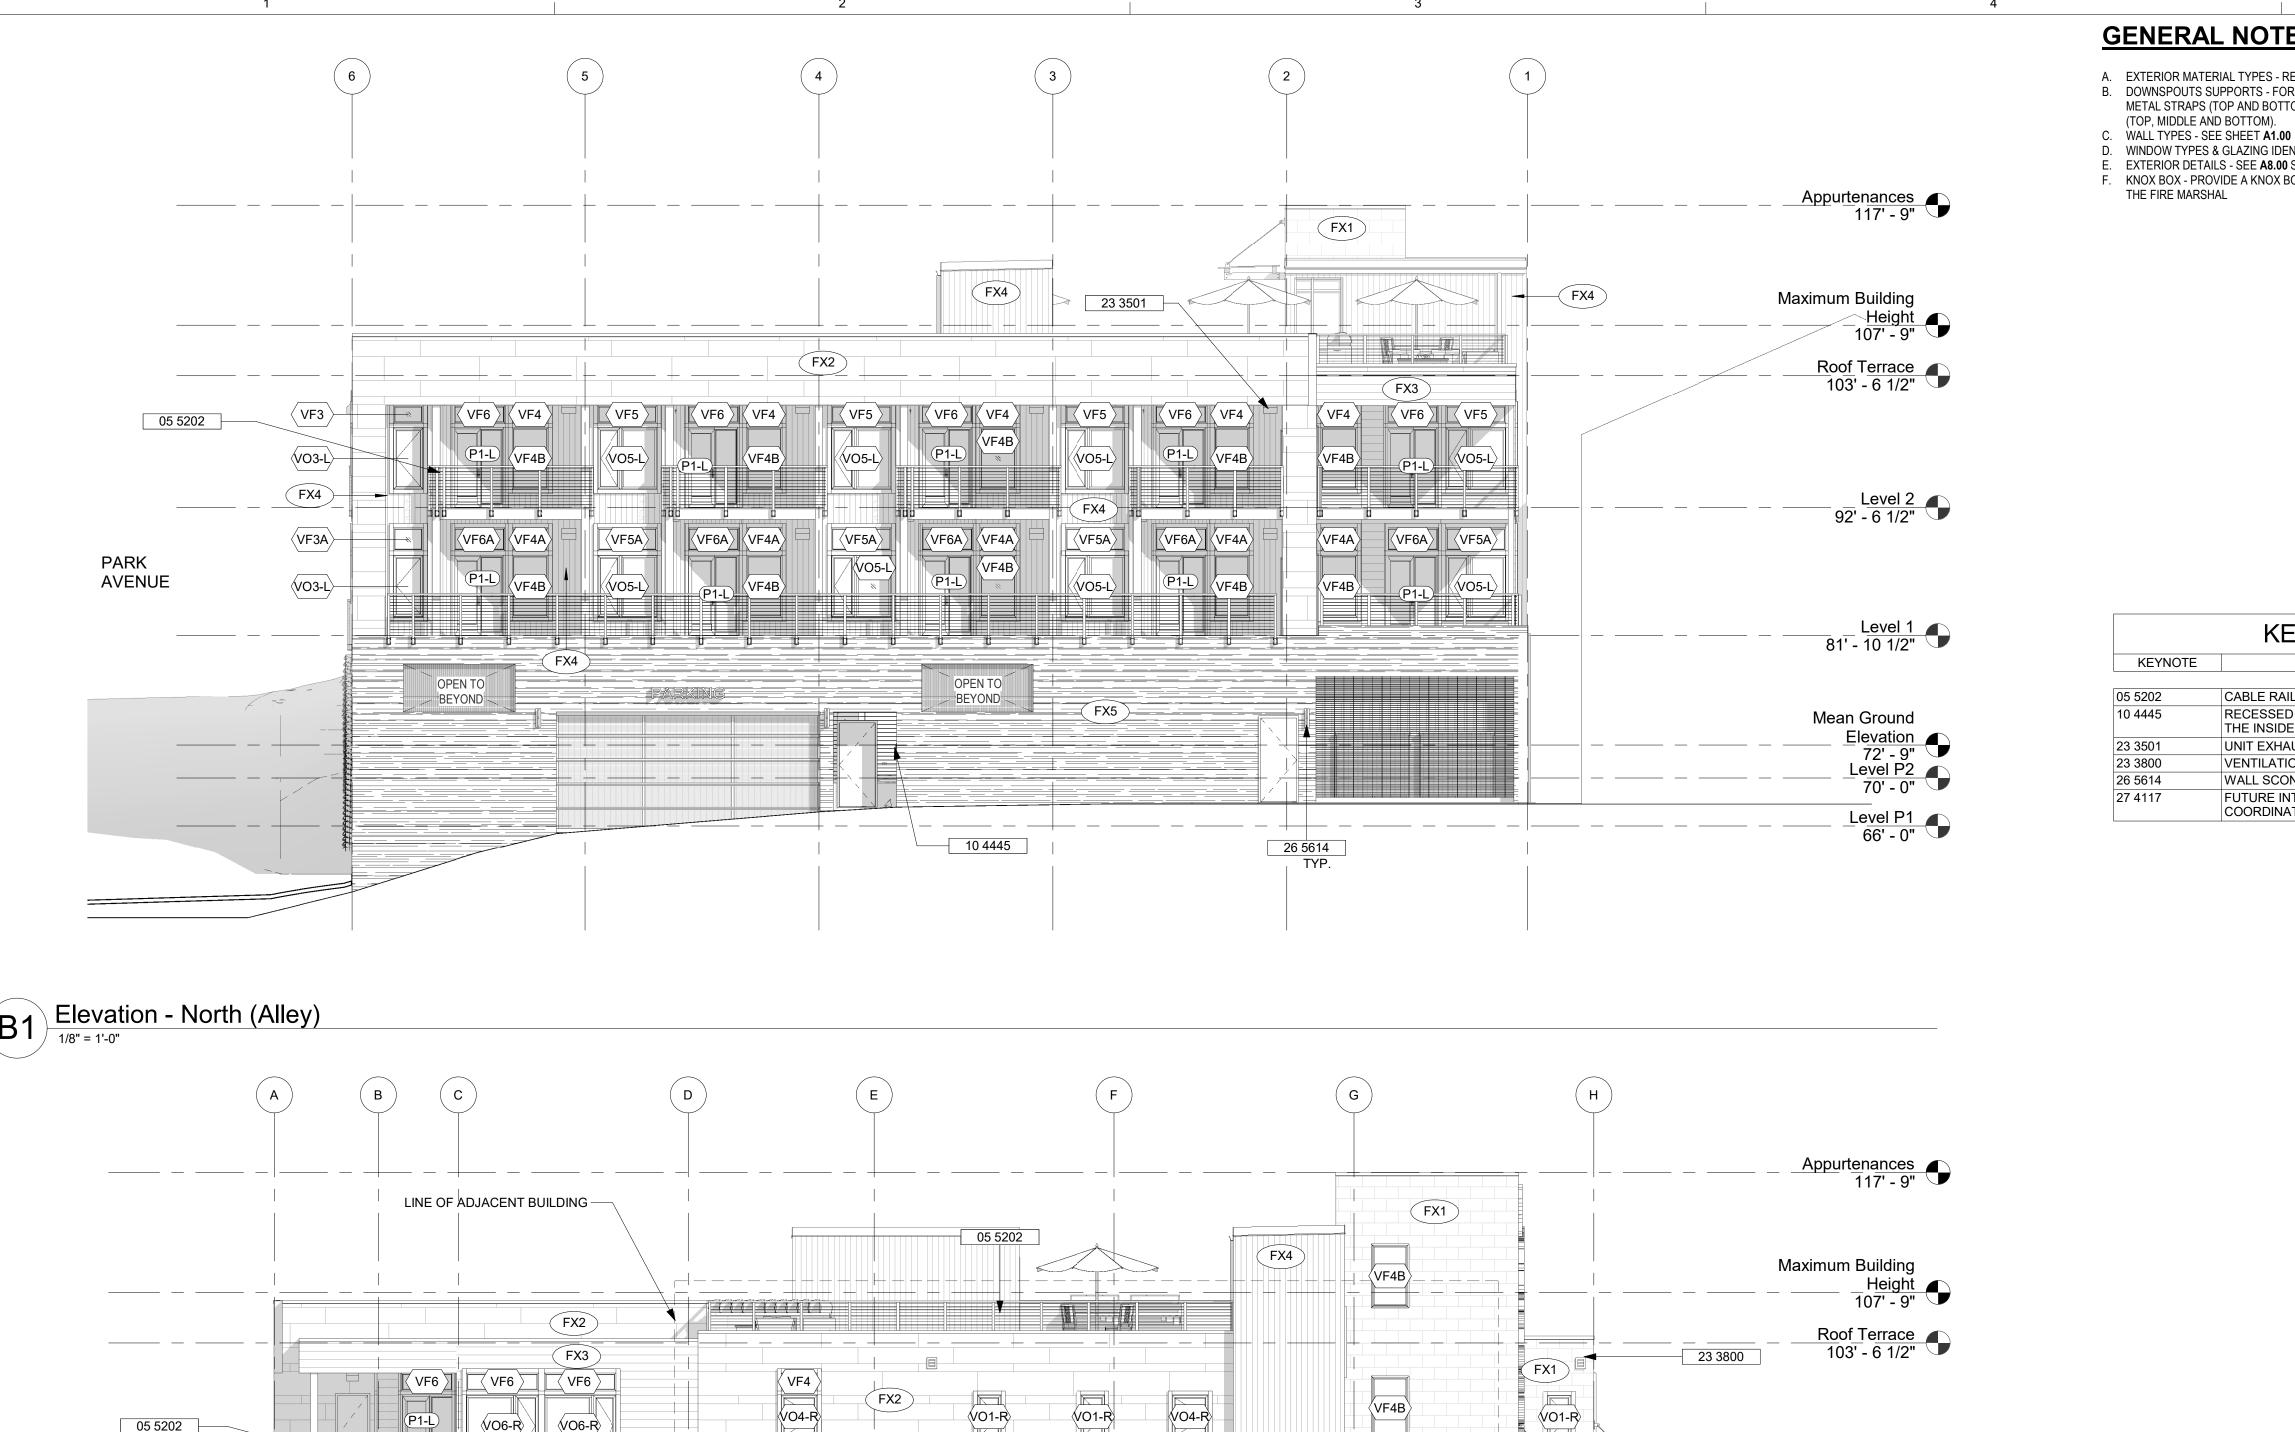

V01-R

SF1

10 4445

27 4117

VF4B

3

VO4-R

(VO1-R)

23 3501

Level 2 92' - 6 1/2"

Mean Ground

Elevation 72' - 9"

Level P1 66' - 0"

THIRD STREET

GENERAL NOTES - EXTERIOR ELEVATIONS

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- METAL STRAPS (TOP AND BOTTOM). 12'-0" AND LONGER PROVIDE 3 PREFINISHED METAL STRAPS (TOP, MIDDLE AND BOTTOM).
- D. WINDOW TYPES & GLAZING IDENTIFICATION REFER TO WINDOW SCHEDULE ON SHEET A7.20
- EXTERIOR DETAILS SEE **A8.00** SERIES SHEETS
- F. KNOX BOX PROVIDE A KNOX BOX AS SPECIFIED. COORDINATE LOCATION WITH THE OWNER AND THE FIRE MARSHAL



CONSULTANT:

KEYNOTE LEGEND KEYNOTE TEXT KEYNOTE CABLE RAIL GUARDRAIL PER MFR RECESSED APPROVED KNOX KEY BOX MOUNTED AT 64" AFFL TO THE INSIDE TOP OF THE BOX UNIT EXHAUST VENT VENTILATION HOODS WALL SCONCES FUTURE INTERCOM/CALL SYSTEM DIRECTORY LOCATION. COORDINATE W/ ELECTRICAL

REGISTRATION STAMPS:



PROJECT IDENTIFICATION:

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01/30/2023 BUILDING PERMIT

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MATERIAL LEGEND - EXTERIOR ELEVA	ATIONS -
FX1 STONE VENEER	
FX2 FIBER CEMENT PANEL	
FX3 FIBER CEMENT LAP SIDING 7" EXPOSURE	
FX4 WOOD-LOOK VERTICAL SHIP-LAP SIDING	
FX5 CONCRETE - CAST-IN-PLACE BOARD-FORM FINISH	

PROJECT TEAM: PRINCIPAL IN CHARGE: MAS PROJECT MANAGER: | AM PROJECT ARCHITECT: | WDH JOB CAPTAIN:

DRAWING TITLE:

EXTERIOR ELEVATIONS

DRAWING NUMBER:

A2.11

SEE - FINISH MATERIAL KEY ON SHEET **AX.XX** FOR PAINT COLORS.

Elevation - West 1/8" = 1'-0"

(VF4A)

VO4-R

√01-R

(VO1-R)

⟨VO6-R⟩

VF6A

⟨VO6-R⟩

√06-R

⟨VF6A⟩

√06-R

VF6A

FX5

05 5202

23 3501

ALLEY

1/27/2023 2:09:56 PM

SITE INFORMATION

00596900300601 Parcel Number(s):

Section 4 Township 28 Range 4 Quarter NE THOMAS Legal Description(s): ADDITION BLK 003 D-00- PAR 1 PER CITY OF MUK LLA REC

UND AFN 201610270134 & AS DEPICTED ON ROS REC UND AFN 201610275001; BEING A PTN OF LOTS 6 & 70F EXST

3RD & PARK AVE **Building Address:** MUKILTEO, WA 98275

Owner: 5J WILLIAMS FAMILY LLC Owner Address: 19801 50TH AVE W

LYNNWOOD, WA 98036-6416

(425) 355 0353 Owner Phone:

Zoning Area: DOWNTOWN BUSINESS DISTRICT Zoning Designation:

DEFERRED SUBMITTALS

- FIRE SERVICE MAIN PERMIT
- NFPA 13 FIRE SPRINKLER SYSTEM PERMIT
- FIRE ALARM SYSTEM PERMIT MECHANICAL PERMIT
- ELECTRICAL PERMIT
- PLUMBING PERMIT SIGNAGE PERMIT

GOVERNING CODES

- INTERNATIONAL BUILDING CODE (IBC), 2018 EDITION & WAC 51-50
- ACCESSIBLE AND USABLE BUILDINGS & FACILITIES, ANSI A117.1-2009 & WAC 51-51-005
- WASHINGTON STATE ENERGY CODE (WSEC), 2018 EDITION, WAC 51-11 (C, R,
- INTERNATIONAL FIRE CODE (IFC), 2018 EDITION AND WAC 51-54
- NATIONAL ELECTRICAL CODE (NEC), 2018 EDITION & WAC 296-46B-010
- NFPA STANDARD 72, 13, 2019 EDITIONS MUKILTEO MUNICIPAL CODE, TITLE 17 ZONING

LAND USE/ZONING

Applicable Code:

Side, Corner:

Side, Interior:

14 / 4 = 3.5

Parking Provided:

COMMERCIAL SPACE

3 STALLS / 1.000 SF GROSS

Maximum Hard Surface

Coverage:

GUEST STALLS @ 1/EVERY 4 UNITS

1,980 SF / 1,000 SF = 1.98 x 3 = 6 STALLS

TOTAL PARKING REQUIRED = 31 STALLS

MMC 17.56.040 Spaces required TABLE 17.56.040

= 21 STALLS

14 - 1 BEDROOM UNITS @ 1.5 STALLS/UNIT

Mukilteo Municipal Code

None (MMC 17.20.025.26)

Downtown Business = 100%

17 STANDARD STALLS

1 ACCESSIBLE STALL 4 ON-STREET SPACES*

* ADJACENT ON-STREET PARKING ON THIRD STREET IS AVAILABLE TO

THE PROJECT (MMC 17.56.045 Special provisions for downtown business

12 LARGE STALLS PROVIDED

= 34 STALLS PROVIDED ON SITE*

MMC 17.20.028 Maximum hard surface coverage matrix TABLE 3

MMC 17.25A.030 Design Standards for the DB District MMC za Lot and structure requirements TABLE 1 17.25A.030.A.2.a.ii Minimum Lot Area: > 40% facing street of Street Level reserved for non-+/-10,850 SF (0.25 acres) residential uses: Parcel Size: Minimum Lot Width: 25'-0" 100'-0" Actual Lot Width: Minimum Average Depth: Actual Lot Depth: MMC 17.20.020 Structure bulk matrix TABLE 2 Maximum Lot Coverage: None Maximum Building Height: 35'-0" (Refer to Diagram on this sheet for **PEDESTRIAN** Mean Ground Elevation calculation) ENTRIES -Proposed Building Height: **Total Stories:** LANDSCAPED Setbacks └ NON-RESIDENTIAL USES Front: None (MMC 17.20.025.26) Rear (with alley): 17.25A.030.A.2.b.i

17.25A.040.A.1.b.iv

17.25A.040.A.4.b.i (A)

17.25A.040.A.4.b.i (B)

17.25A.040.A.4.b.i (C)

17.25A.040.A.4.b.i (D)

17.25A.040.A.4.b.i (E)

17.25A.040.A.4.b.i (F)

17.25A.040.A.4.b.ii (A)

17.25A.040.A.4.b.ii (B)

17.25A.040.A.4.b.ii (C)

17.25A.040.A.4.b.ii (D)

17.25A.040.A.5.b.i

17.25A.040.A.5.b.ii

17.25A.040.A.5.b.iii

17.25A.040.A.5.b.iv

Pedestrian entryways provide access to both residential and commercial-retail uses. 17.25A.030.A.2.b.ii Total portion of lot frontage width used for pedestrian entryways is < 24'-0" wide. Dwelling units are located above and behind commercial-retail 17.25A.030.B.2.a

17.25A.030.B.2.b Required parking for residential uses is located on site. 17.25A.040.A.1.b.i Building is located on the front property line adjacent to the 17.25A.040.A.1.b.ii A universally accessible path is provided from the sidewalk to

the building's entry. 17.25A.040.A.1.b.iii Parking garage is accessible only from alley.

> Located on Park Avenue, our building meets the edge of the sidewalk, provides a visible entry on the corner of Park & 3rd St, and provides screening from the sidewalk to the Parking Garage towards the alley.

17.25A.040.A.2.b.i Pedestrian access provided from the main street. 17.25A.040.A.2.b.ii Access complies with federal, state and local codes for ADA. 17.25A.040.A.2.b.iii Project is only one building. Bicycle Parking (14 racks = 1 per unit) is provided inside the 17.25A.040.A.3.b.i

Parking Garage. 17.25A.040.A.3.b.ii The areas adjacent to the sidewalk are designed to not impede

bicycle traffic. Trash/Recycling on alley to be screened with roll-up door.

Interior lot line shared with Commercial property. 17.25A.040.B.7.b.i The enclosure for recyclable and garbage collection point is located within the Parking Garage, along the alley. 17.25A.040.B.7.b.ii

The project does not have loading areas nor outdoor storage The project does not have solid waste receptacles and service

areas visible from the sidewalk. The project does not have screened trash containers, only a recyclable and garbage collection point enclosure.

Utility meters will be located in the Electrical Room on the alley. All mechanical equipment will be located and screened at ground level and attached to structures to reduce the visual impacts from adjoining properties.

Roof-mounted mechanical equipment will be screened by parapet on the roof, and will match the exposed color of the roof. Utility meters will be located in the Electrical Room on the alley.

Building is located on both corner property lines. The corner of 3rd St and Park Ave is pedestrian-oriented with a business entrance at the corner. Corner is distinct in form as well as material from the remainder of

Concrete wall along Park Ave, more than 20'-0" long, to be board formed, providing decorative element.

17.25A.040.A.6.b.i Parking garage accessed from alley. 17.25A.040.A.6.b.ii No vehicle access route via the street, only alley access. 17.25A.040.A.6.b.iii No vehicle access route via the street, only alley access.

Vehicle access via alley.

Building design does not include gabled roofs. Each of the 14 Residential units has a deck along the facades, facing the alley and Park Ave. The 2nd floor residential unit that abuts 3rd St has a deck facing the corner of 3rd St and Park Ave.

> Unit windows jut out and back at decks, providing visual interest. Both stair towers extend above the lower roof and are distinguished materially.

All of the facade on both 3rd St and Park Ave is pedestrianoriented space, thus providing much more than 15sf/10 lineal feet. The first floor of the building is devoted to Commercial space along 3rd St, and therefore the windows there are storefront with large glazing, but separated by > 6" wall sections.

At the corner of 3rd St and Park Ave, there is a covered entry to the Commercial space.

There are (2) canopies along the 3rd St facade, spanning 61'-6" Residential units on the first and second floor setback 8'-0"+ at

17.25A.040.B.2.b.ix The canopies along 3rd St facade provide pedestrian-orientation.

Unit decks are all significantly greater than 40sf in size. 17.25A.040.B.3.b.i.(A) 17.25A.040.B.3.b.i.(B).(1) The project has flat, unmodulated roofs. However, since there are multiple roof levels, as well as a roof terrace, visual interest is

17.25A.040.B.3.b.i.(C) All dwelling units have the same window patterns, thus creating repeating visual pattern.

17.25A.040.B.3.b.i.(D) All dwelling units have a deck, thus creating repeating visual

17.25A.040.B.3.b.i.(E) Roofs are stepped to multiple levels 17.25A.040.B.3.b.i.(F) Materials change with each building volume.

17.25A.040.B.2.b.vi

17.25A.040.B.2.b.vii

17.25A.040.B.2.b.viii

17.25A.040.B.3.b.i.(H)

17.25A.040.B.4.b.i.(A)

17.25A.040.B.4.b.i.(B)

17.25A.040.B.4.b.i.(C)

17.25A.040.B.4.b.i.(D)

17.25A.040.B.4.b.ii

17.25A.040.B.5.b

17.25A.040.B.6.b

17.25A.040.B.7.b.iii

17.25A.040.B.7.b.iv

17.25A.040.B.8

17.25A.040.B.9.b.i

17.25A.040.B.9.b.ii

17.25A.040.B.10.b

17.25A.040.C.1.b

17.25A.040.C.2.b

17.25A.040.C.3.b

17.25A.040.C.4.b.i

17.25A.040.C.4.b.ii

17.25A.040.C.4.b.iii

17.25A.040.D.a.ii

17.25A.040.D.b, c


17.25A.040.E

17.25A.040.F

17.25A.040.G

17.25A.040.B.3.b.i.(G) Light fixtures and planters are provided in repeat pattern along 3rd

> No facade in the project exceeds 120'-0" width. The Commercial/retail facade on 3rd St has 85% glazing at the

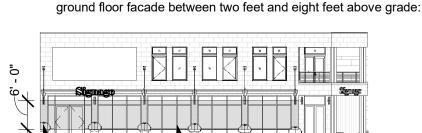

46SF SOLID WALL 277SF GLAZING

Principal building entry faces 3rd St and is accessed directly from

The sidewalk-accessible facade on 3rd St is 99% protected from weather with >5'-0" deep canopies.

No exemption needed.

Service areas (Electrical Room, Trash/Recycling) are located at the alley, not the pedestrian-oriented street.

Project corner provides a corner entrance as well as corner architectural elements: Balcony on upper story, corner windows. Project provides the following design features: decorative light fixtures, decorative stone cladding, planters at part of landscape

treatment, and decorative paving. Building exteriors to include stone cladding, fiber cement siding, and wood-look cladding.

None of the prohibited materials will be used in project.

None of the special materials will be used in project.

The strorefront's pallette shall not have more than three colors.

Blank walls to be board-formed cast-in-place concrete, for visual and textural interest.

The principal building entrance is at 3rd St and to be covered, lighted, have signage, be visible from the sidewalk, have glazing for transparency, be secure with intercom/call-box, and have architectural/artwork enhancements.

Secondary entrance is at Park Ave and to be covered, and have

Parking Garage to be secured, obscure view of cars at grade, and to be constructed of board-formed cast-in-place concrete walls, to provide visual and textural interest.

Sidewalk along 3rd St to be min 11'-10" wide, and lighting to be provided along face of building at all sidewalks.

Project to provide pedestrian amenities including concrete bench near primary entry, decorative lighting, and pavement patterns at

Project fills the site, so will not have internal pedestrian paths, but supports pedestrian travel on 3rd St and Park Ave.

corner of the site will provide visual interest and garden feel. Project to achieve pedestrian-orientation via concrete bench near building entry and adjacent retail facade with >75% glazing.

Planted landscape area to be located on 3rd St at southwest

The project will avoid all of the items listed that do not enhance pedestrian-oriented space.

All parking standards being met, please see A1.10 and Parking Analysis on this sheet.

Only structured parking, no lot at grade.

Project intends to meet all Landscaping requirements and will further develop landscape plans as it proceeds.

Project intends to meet all Signage requirements and will further develop signage design package as it proceeds.

Project intends to meet all Site Lighting requirements and will further develop lighting package with engineer as it proceeds.

DYKEMAN ARCHITECTURE + DESIGN www.dykeman.net 1716 West Marine View Drive 425.259.3161 **(T)** 2nd Floor / Everett, WA 98201

CONSULTANT:

REGISTRATION STAMPS:



PROJECT IDENTIFICATION:

Williams Invest -Third and Park 5J WILLIAMS **FAMILY LLC**

3RD & PARK AVE

BUILDING PERMIT

01/30/2023

MUKILTEO, WA 98275

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PROJECT NUMBER:

2021-042

REVISIONS:					
MARK	DATE	DESCRIPTION			
	01/30/2023	BUILDING PERMIT			

PROJECT TEAM:

PRINCIPAL IN CHARGE: MAS PROJECT MANAGER: | AM PROJECT ARCHITECT: | WDH JOB CAPTAIN:


DRAWING TITLE:

PROJECT INFORMATION & ZONING CODE ANALYSIS


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LOCATION MAP

BUILDING HEIGHT CALCULATION

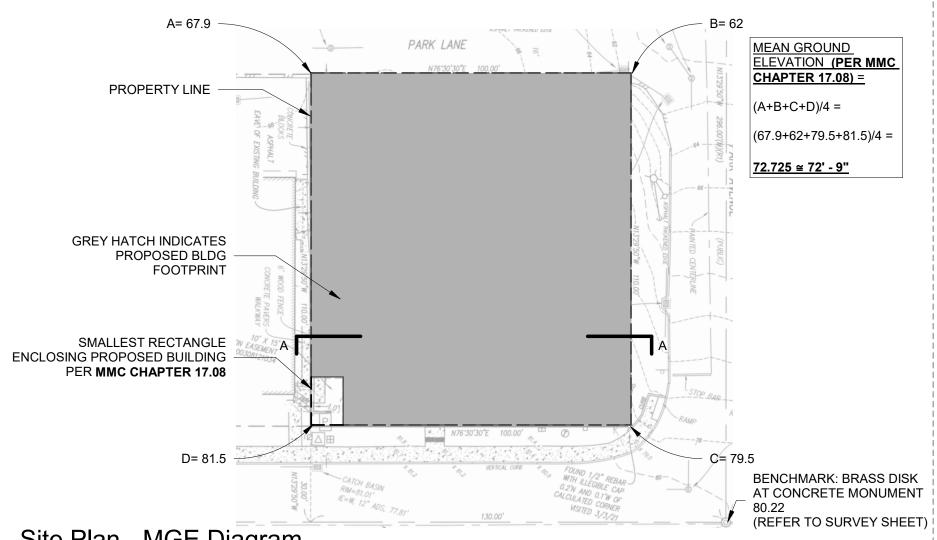

Site Plan - MGE Diagram Appurtenances Roof Terrace 17.25A.040.A.6.b.iv 117' - 9" 103' - 6 1/2" Maximum Building 17.25A.040.A.7.b Roof Plate 101' - 5" 17.25A.040.B.2.b.i Level 2 92' - 6 1/2" 17.25A.040.B.2.b.ii Level 1 Mean Ground 17.25A.040.B.2.b.iii 81' - 10 1/2" Elevation Level P2 70' - 0" 17.25A.040.B.2.b.iv Level P1 17.25A.040.B.2.b.v Section A-A

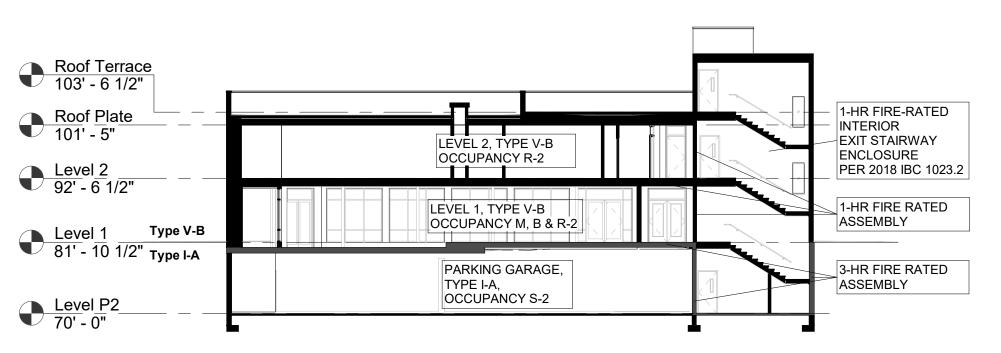

Section A-A Life Safety

Room Number	Room Name	Area	Occupancy Classification	Occupancy Group	Occupant Load Factor	Occupant Load
Level P2					L	
P01	GARBAGE/RECYCLING	235 SF	UTILITY	U	300 SF	1
P02	ELEC	114 SF	UTILITY	U	300 SF	1
P03	RISER RM	48 SF	UTILITY	U	300 SF	1
P04	PARKING GARAGE	9,371 SF	STORAGE	S-2	200 SF	47
P05	ELEVATOR MACHINE ROOM	49 SF	UTILITY	U	300 SF	1
						51
Level 1 101	1BR	1,012 SF	RESIDENTIAL	R-2	200 SF	6
101S	EXT STORAGE	5 SF	STORAGE	S-2	200 SF	1
1010	1BR	1,141 SF	RESIDENTIAL	R-2	200 SF	6
102S	EXT STORAGE	5 SF	STORAGE	S-2	200 SF	1
1020	1BR	717 SF	RESIDENTIAL	R-2	200 SF	4
104	1BR	688 SF	RESIDENTIAL	R-2	200 SF	4
105	1BR	849 SF	RESIDENTIAL	R-2	200 SF	5
106	1BR	693 SF	RESIDENTIAL	R-2	200 SF	4
109	COMMERCIAL SPACE 2	819 SF	MERCANTILE	M	60 SF	14
110	COMMERCIAL SPACE 1	936 SF	MERCANTILE	M	60 SF	16
114	LEASING OFFICE	175 SF	BUSINESS	В	150 SF	2
117	JANITOR	31 SF	UTILITY	U	300 SF	<u>-</u> 1
_evel 2	o, uniter (0.7.01	U.L.I.		000 0.	64
201	1BR + DEN	1,194 SF	RESIDENTIAL	R-2	200 SF	6
201S	EXT STORAGE	5 SF	STORAGE	S-2	200 SF	1
202	1BR	1,086 SF	RESIDENTIAL	R-2	200 SF	6
202S	EXT STORAGE	5 SF	STORAGE	S-2	200 SF	1
203	1BR	685 SF	RESIDENTIAL	R-2	200 SF	4
204	1BR	688 SF	RESIDENTIAL	R-2	200 SF	4
205	1BR	849 SF	RESIDENTIAL	R-2	200 SF	5
206	1BR	687 SF	RESIDENTIAL	R-2	200 SF	4
207	1BR	1,264 SF	RESIDENTIAL	R-2	200 SF	7
208	1BR	1,118 SF	RESIDENTIAL	R-2	200 SF	6
Roof Plat	e					44
RT02	ROOF TERRACE	1,505 SF	ASSEMBLY	A-3	15 SF	101
		.,	1.332			101
		OAD (PER 201				

TRAVEL PATH ANALYSIS			
Travel Path	Travel Distance		
P1-01	92'		
P1-02	113'		
1-01	108'		
1-02	147'		
2-01	98'		
2-02	115'		
R-01	63'		
R-02	68'		


MAXIMUM TRAVEL DISTANCE PER IBC 1017:

S-2 OCCUPANCY 400' B OCCUPANCY 300' 250' A-3 OCCUPANCY 250' R-2 OCCUPANCY M OCCUPANCY 250' 1. Refer to Door Schedule on sheets A7.10 for panic hardware locations.

2. All exits shall be provided with a tactile exit sign.

3. All assembly spaces shall be provided with a maximum occupant load sign.

4. All Fire Extinguishers are located within maximum 75 distance of any occupiable building location.

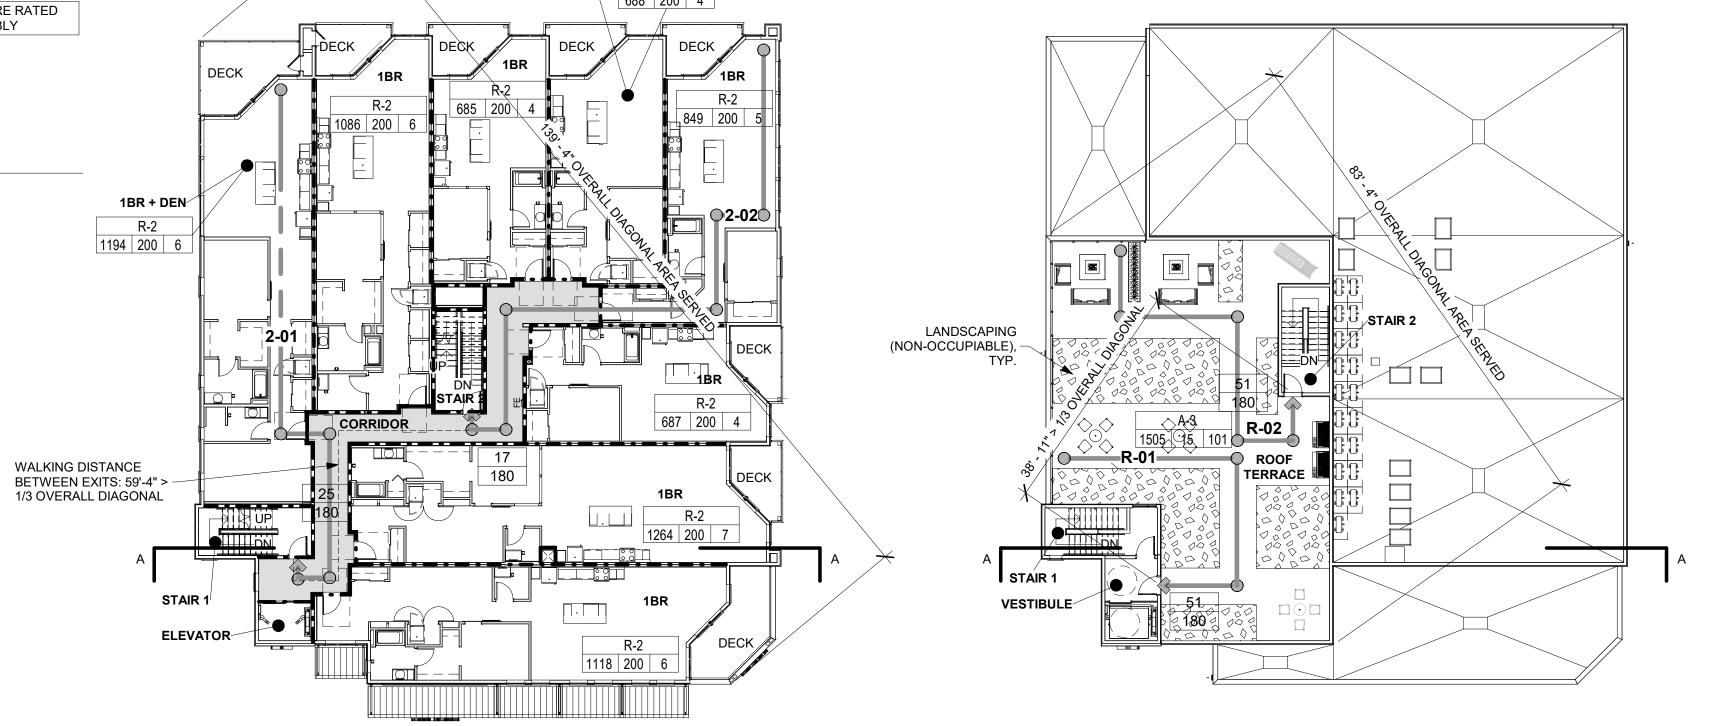

EXIT SYMBOL CODES


OCCUPANT LOAD

OCCUPANT LOAD FACTOR

- # OF PEOPLE USING EXIT

EXIT FROM FLOOR

EXIT CAPACITY

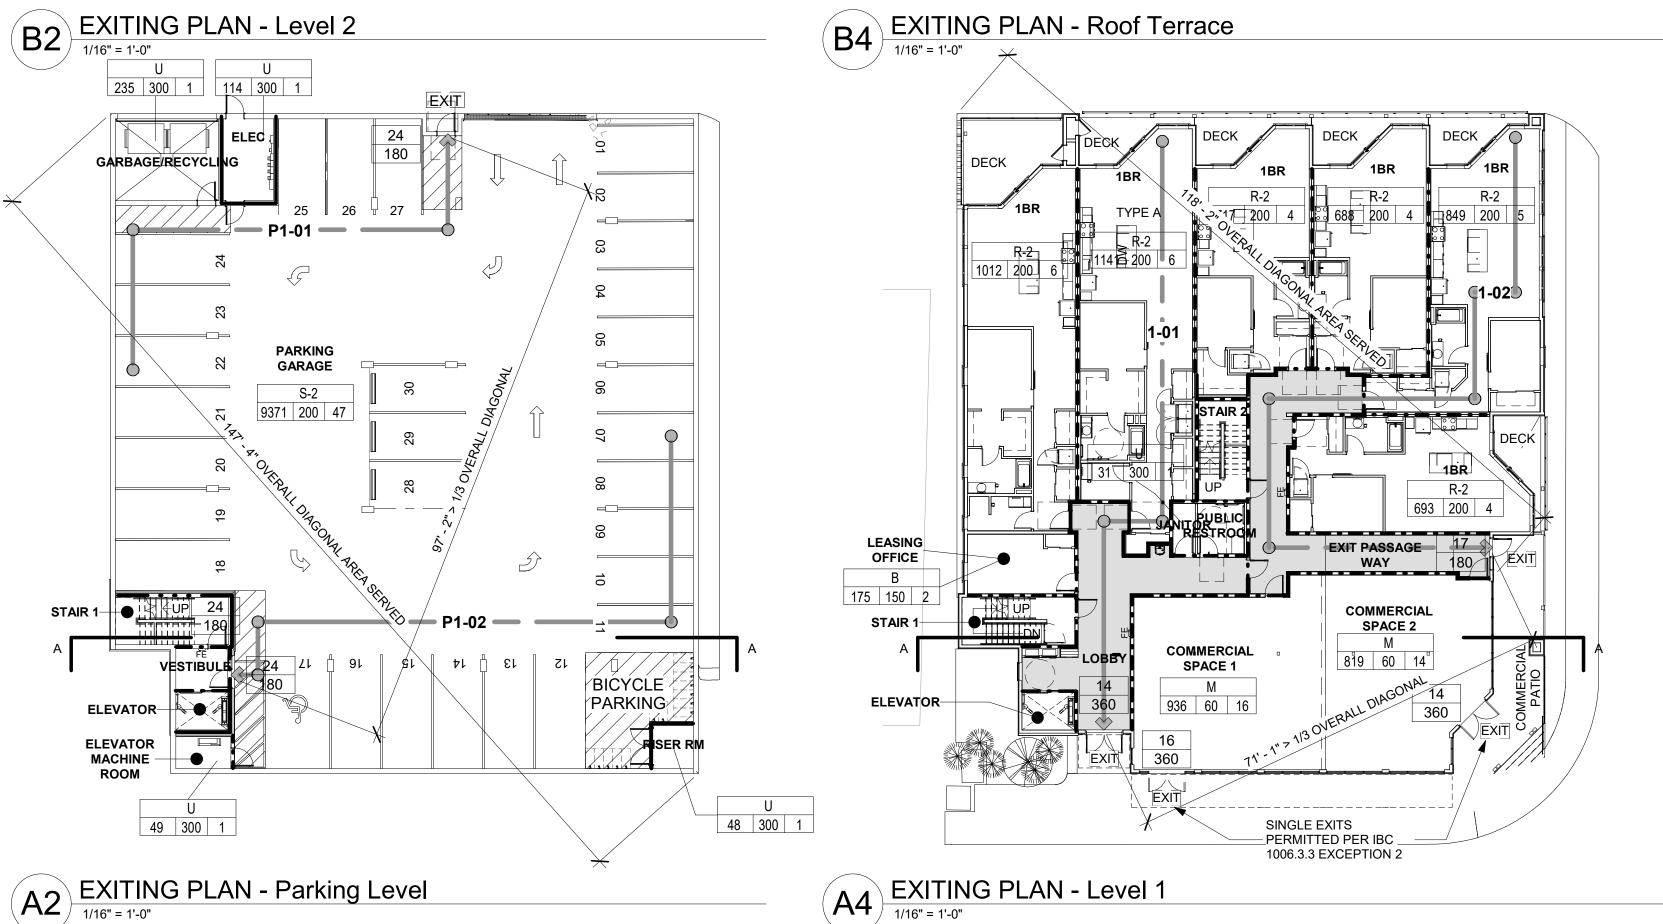

3



CONSULTANT:

REQUIRED FIRE SEPARATIONS KEY

EXIT

FIRE-RATED CORRIDOR

INDICATES 2-HR

FIRE-RATED

VERTICAL EXIT

PASSAGEWAY

---- 1 HOUR FIRE RATED

EXIT

SEPARATION

UP TO 3 HOUR FIRE RATED SEPARATION

FIRE EXTINGUISHER IN

OR WALL-MOUNTED AT

PARKING GARAGE

SEMI-RECESSED CABINET

REGISTRATION STAMPS:



PROJECT IDENTIFICATION:

Williams Invest -Third and Park FOR 5J WILLIAMS FAMILY LLC

AT 3RD & PARK AVE MUKILTEO, WA 98275

BUILDING PERMIT 01/30/2023

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2021-042

REVISION	JNJ.	
MARK	DATE	DESCRIPTION
	01/30/2023	BUILDING PERMIT

PRINCIPAL IN CHARGE: MAS

PROJECT TEAM:

PROJECT MANAGER: | AM PROJECT ARCHITECT: | WDH JOB CAPTAIN:

DRAWING TITLE:

LIFE SAFETY ANALYSIS

DRAWING NUMBER:

Williams Invest - Third and Park

PROJECT DEVELOPED FOR

5J WILLIAMS FAMILY LLC



PROJECT TEAM

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EMAIL:

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BEE ENGINEERS 170 W. DAYTON STREET, STE 206 EDMONDS, WA 98020 CONTACT: Chad Smith (425) 672 3900

chad@bee-engineers.com



REGISTRATION STAMPS



PROJECT IDENTIFICATION:

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5J WILLIAMS FAMILY LLC

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DRAWING ISSUE DATES:						
BUILDING PERMIT	01/30/2023					

PROJECT TEAM:

PRINCIPAL IN CHARGE: MAS PROJECT MANAGER: | AM PROJECT ARCHITECT: | WDH JOB CAPTAIN:

DRAWING TITLE:

COVER SHEET

DRAWING NUMBER:

G0.1